

	F.A.P. R.T.E.	SECTION	COUNTY	TOTAL SHEETS	SHEET. NO.	
		06-00199-00-LS	COOK	19	5	
		LIGHTING PLAN (2 OF 4)				
ł			ILLINOIS	630.	41	

## **LEGEND**

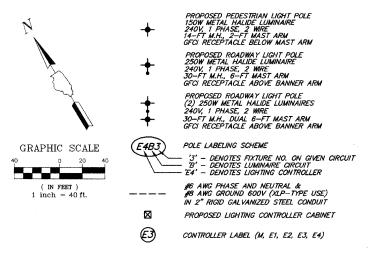

POLE PLACEMENT US RT 14 (MINER ST) SETBACK\* STATION CIRCUIT POLE LABEL 9.5 10+84 MA11 3.0 11 + 743.0' 12+48 MD5 0.5 12+48 3.0' 13+17 13+55 В MB1.3 15.0' 14+20 4.0' MA13 20.0 14+28 MB14 14+72 MA14 6.0" 15+30 15+62 В MB15 6.0' 6.0' MA15 16+12 MB16 17+29 6.0' MA16 18+08

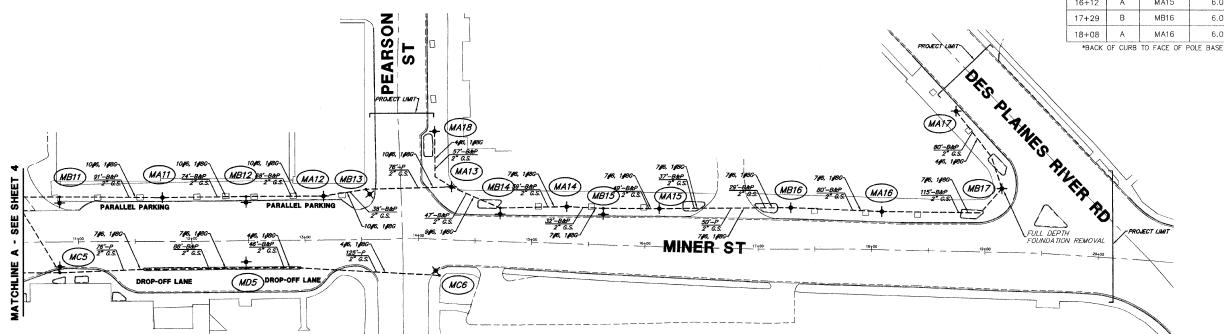

## BENCH AND TRASH RECEPTACLE INSTALLATION NOTES: BENCH AND TRASH RECEPTACLE INSTALLATION NOTES: 1. ALL PROPOSED BENCHES AND TRASH RECEPTACLES ARE TO BE INSTALLED AT LOCATIONS DESIGNATED AND MARKED BY THE ENGINEER. 2. PLACEMENT OF EACH BENCH AND TRASH RECEPTACLE IS AS FOLLOWS: 6 — ALONG MINER STREET BETWEEN PEARSON STREET AND LEE STREET 4 — ALONG OAKTON STREET BETWEEN WHITE STREET AND U.S RT 12/45 (LEE STREET/MANNHEIM ROAD)

PLANS PREPARED BY:

GEWALT HAMILTON

ASSOCIATES, INC.

Consulting Engineers & Surveyors 350 Forest Edge Drive Vernon Hills, IL 60061 (847) 478-9700 (847) 478-9701 Fax

LICHTING INSTALLATION NOTES:

1. ALL PROPOSED LIGHTING UNITS ARE REPLACEMENTS OF EXISTING UNITS IN THE SAME OR NEARBY LOCATION.

2. FOR ROADWAY LUMINAIRES MOUNTED ON COMBINATION TRAFFIC SIGNAL MAST ARM ASSEMBLIES, REMOVAL ITEMS INCLUDE THE LUMINAIRE, MAST ARM AND WIRING TO POLE BASE. THE PROPOSED REPLACEMENT LIGHTING UNIT SHALL BE INSTALLED AS A SEPARATE POLE ADJACENT TO THE EXISTING TRAFFIC SIGNAL ASSEMBLY.

REVISIONS

DATE

NAME

CONDUIT INSTALLATION NOTES:

1. EXISITING CONDUIT THAT IS IN SUITABLE CONDITION FOR RE-USE, AS APPROVED BY THE ENGINEER, SHALL REMAIN IN PLACE AND BECOME PART OF THE REMAIN IN PLACE AND BECOME PART OF THE PROPOSED LIGHTING SYSTEM INSTALLATION.

EXISTING CONDUIT THAT IS NOT IN SUITABLE CONDITION FOR RE-USE, AS APPROVED BY THE ENGINEER, SHALL BE ABANDONED IN PLACE, AND NEW CONDUIT SHALL BE INSTALLED AS SHOWN ON THE PLANS.

> ILLINOIS DEPARTMENT OF TRANSPORTATION LIGHTING PLAN (2 OF 4)

DES PLAINES LIGHTING IMPROVEMENTS AND STREETSCAPE DES PLAINES, ILLINOIS

SCALE: 1"=40' DATE: 8-14-2009

DRAWN BY: DRS DESIGNED BY: AJP CHECKED BY: BLS